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Rajat and Pooja Karwal Project Title :

Dual Occupancy & Sec. Dwellings at: L11, 63 Queen Street, Revesby dp2343

# **NOT FOR CONSTRUCTION**

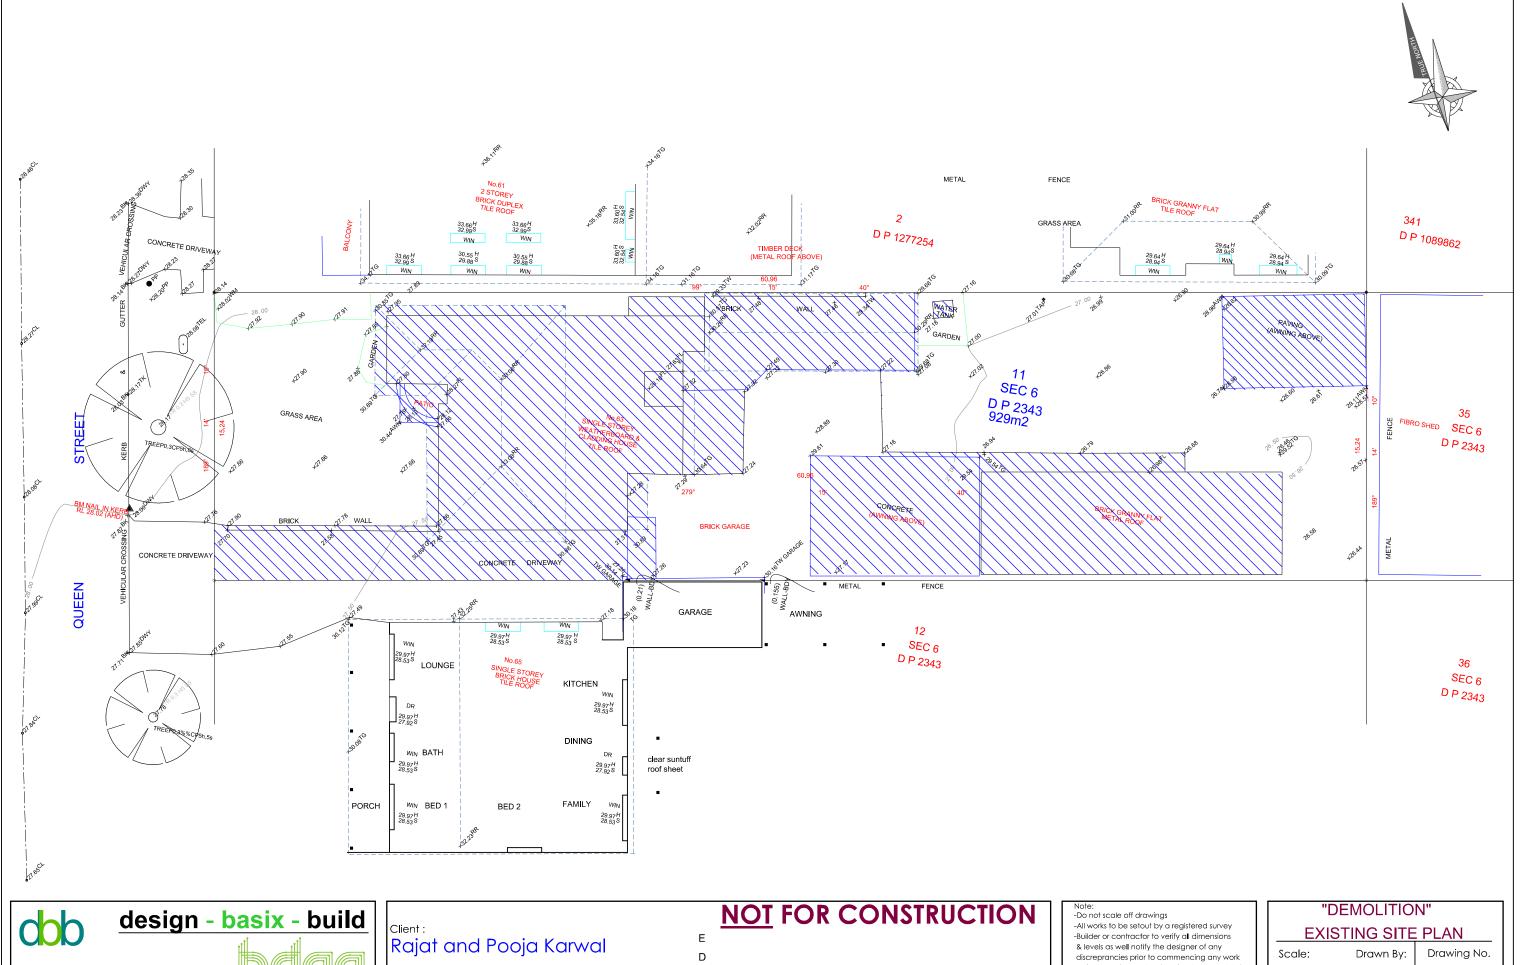
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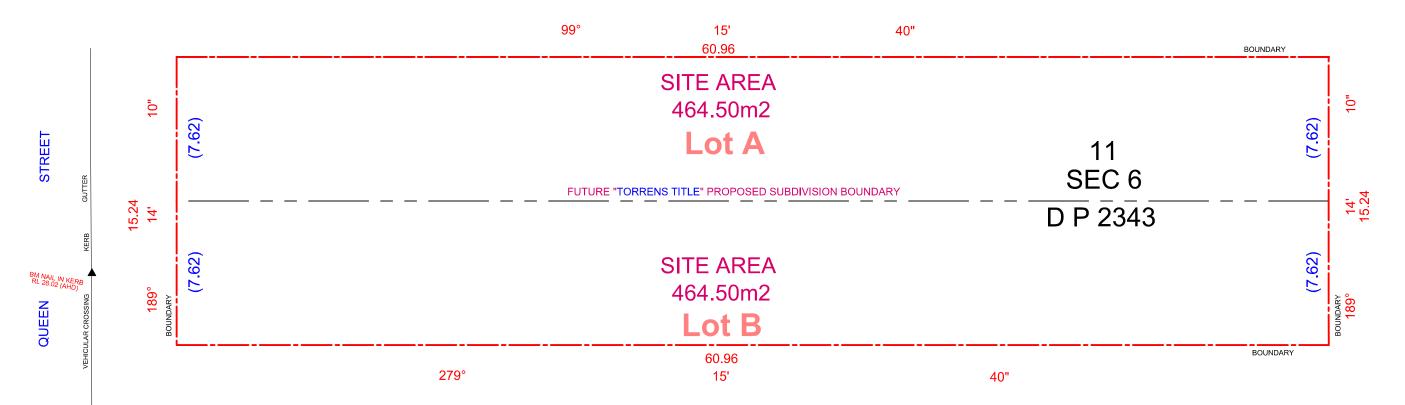
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"DEMOLITION"						
EXISTING SITE PLAN						
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41) Evidence of the registration of the two-lot subdivision with NSW Land and Property Information must be provided to the Certifier, prior to the construction of the secondary dwellings reaching a point where these can be considered habitable dwellings in accordance with the definition of a "dwelling" under the Canterbury Bankstown Local Environmental Plan 2023 (i.e. prior to the installation of wet areas, kitchens and the like).

The construction of the secondary dwellings shall not proceed past that point described above, until evidence of the registration of the two-lot subdivision with NSW Land and Property Information has been provided to the Certifier.

- 42) Prior to the issue of a Subdivision Certificate, the following must be complied with:
- a) The construction of the secondary dwellings shall not proceed past a point where they could be considered habitable dwellings ready for occupation in accordance with the definition of a "dwelling" under the Canterbury Bankstown Local Environmental Plan2023 (i.e. prior to the installation of wet areas, kitchens and the like).
- b) Easements have been created where necessary over the relevant lots on the plan of subdivision under provisions of the Conveyancing Act 1919 as follows:
- i. Easements to drain water (for inter-allotment drainage),
- ii. Easement for services (for utilities),
- iii. Right of carriageway (for internal driveway, vehicle manoeuvring), and
- iv. Easement for overhang (for eaves and gutters).

Note: a statement must be placed on the Section 88B Instrument that nominates Canterbury-Bankstown Council as the authority empowered to release, vary or modify the easements created.

- c) The following information must be submitted to Council or the Principal Certifier with an application for a Subdivision Certificate:
- i. Original Plan of Subdivision signed by a registered surveyor, plus five (5) copies,
- ii. Copy of this Determination Notice and any approved Section 4.55 modifications,
- iii. Evidence that all conditions of consent relevant to the release of the Subdivision Certificate have been complied with.
- iv. A Compliance Certificate (Section 73 of the Sydney Water Act 1994) from Sydney
- v. Certification by a registered surveyor that all services such as stormwater drainage, water, gas, electricity and telephone are contained:
- a) separately within each lot; or
- b) within easements created to accommodate such services;
- or, where such services are not in place at the time of subdivision:
- c) that such services can be accommodated separately within each lot; or
- d) that easements are in place to accommodate such services.

vi. A report from a Registered Surveyor which demonstrates that the height and location of the ground floor slab, and minimum 500mm high brickwork along:

- a) the common wall (for attached dual occupancies); and
- b) the edge of the slab closest to the proposed new Torrens title boundary (for the secondary dwelling(s) and detached dual occupancies);

complies with the approved plans. In this regard, the certificate from the Registered Surveyor is required to identify the finished floor level of the ground floor slab and the offsets to property boundaries.

If construction has progressed to the point where external walls have been erected and the roof constructed at the time of subdivision, the report from the Registered Surveyor must also verify the external wall setbacks and roof eaves overhang to the proposed subdivision boundaries all confirm with the approved





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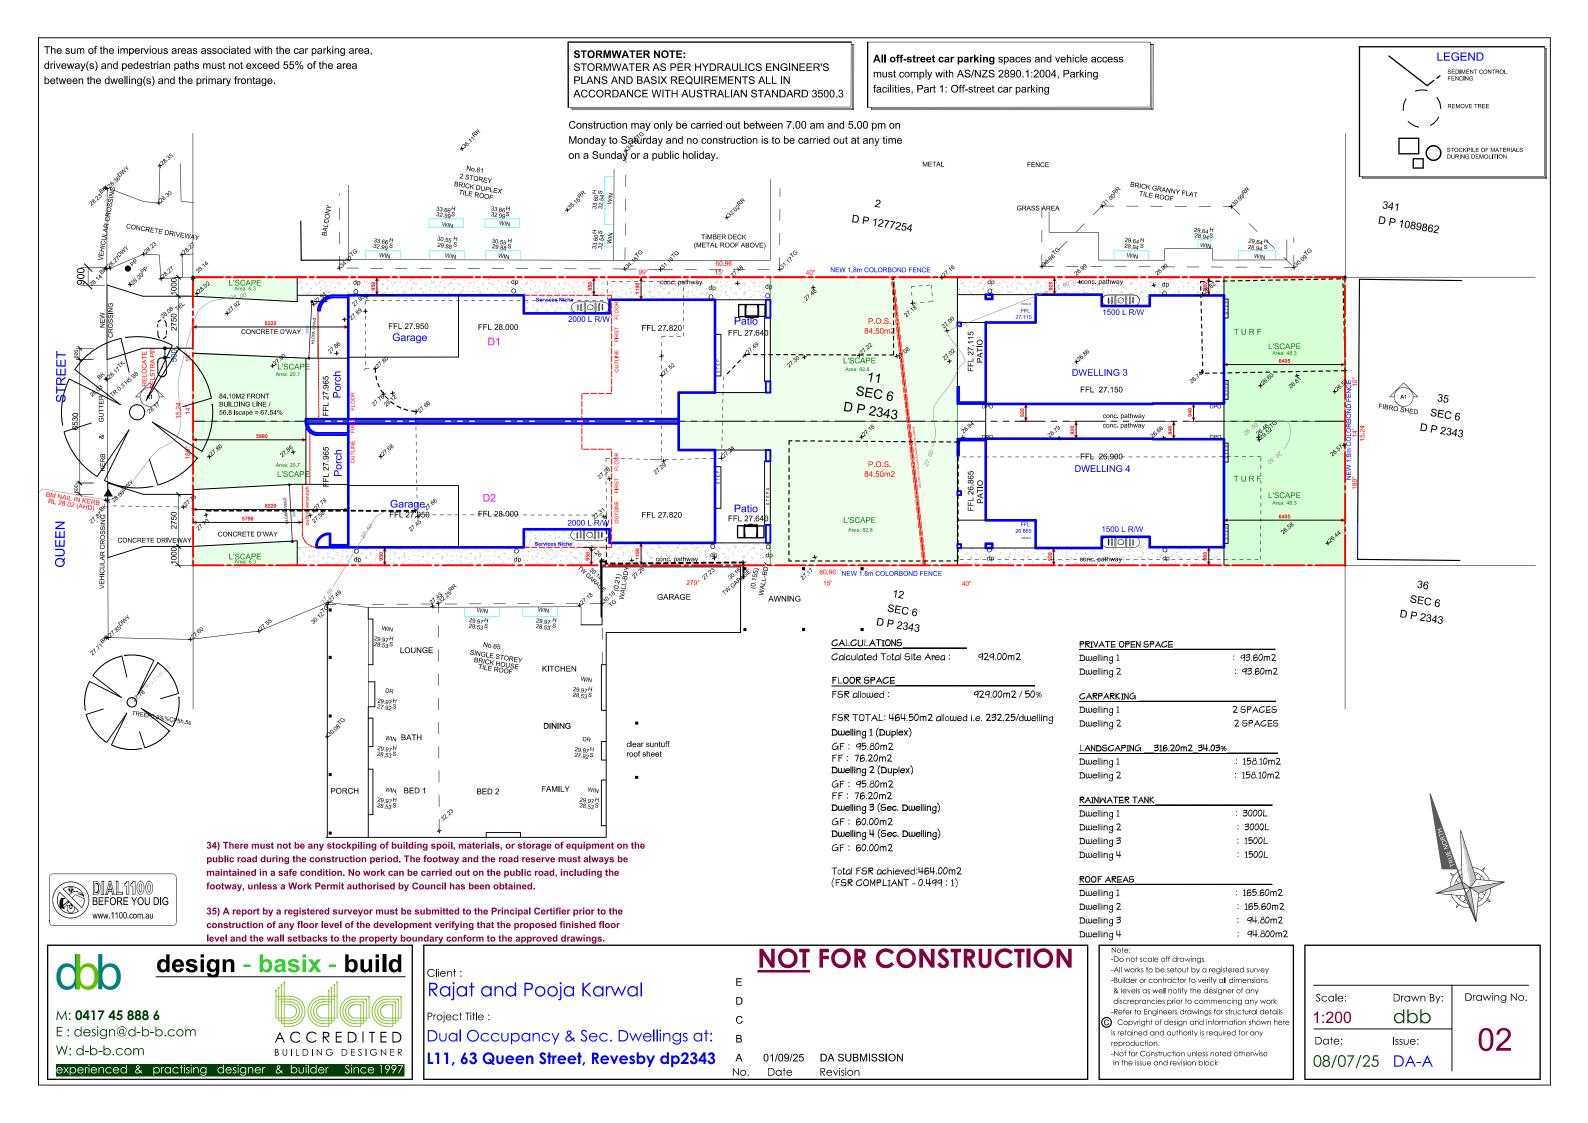
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TORRENS SUBDIVISION					
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	•	Proposed Ground/ Floor Level					
	CSD	Cavity Sliding Door					
	CT	Ceramic Tiling					
	DP	Downpipe					
	DR	Drain					
р	FW	Floor Waste					
Floor Plan Legend	GA	Gas Point					
Θ̈́	LOH	Lift Of Hinges					
٦,	RT	Selected Roof Tiles					
<u>a</u>	SF						
П	STC	Selected Flooring Steel Troweled Concrete					
ō	TFT	Terra-Cotta FloorTiles					
<u> </u>	PTF	Polished Timber Flooring					
ш	SA	Smoke Alarms AS3786-2014					
	V W	Mechanical Ventilation /					
	V W	Externally Ducted					
		Externally Ducted					

17) Sites located adjacent to Councils drainage easement and/or sites affected by flooding shall

a) The proposed building(s) including eaves and gutters shall be located clear of existing and proposed Council easements within the site. Plans demonstrating this requirement are to be submitted to the certifier before the issue of the construction certificate. All approved construction details shall be consistent with this requirement. Proposed buildings shall be located clear of floodways through the site. b) The floor level shall be constructed to RL 17.5 metres AHD for dwelling 1 & 2 and to RL 17.0 meters AHD for dwelling 3 & 4 as determined by the flood study including freeboard. All approved construction details shall be consistent with this requirement.

## STORMWATER NOTE:

STORMWATER AS PER HYDRAULICS ENGINEER'S PLANS AND BASIX REQUIREMENTS ALL IN ACCORDANCE WITH AUSTRALIAN STANDARD 3500.3

All off-street car parking spaces and vehicle access must comply with AS/NZS 2890.1:2004, Parking facilities, Part 1: Off-street car parking

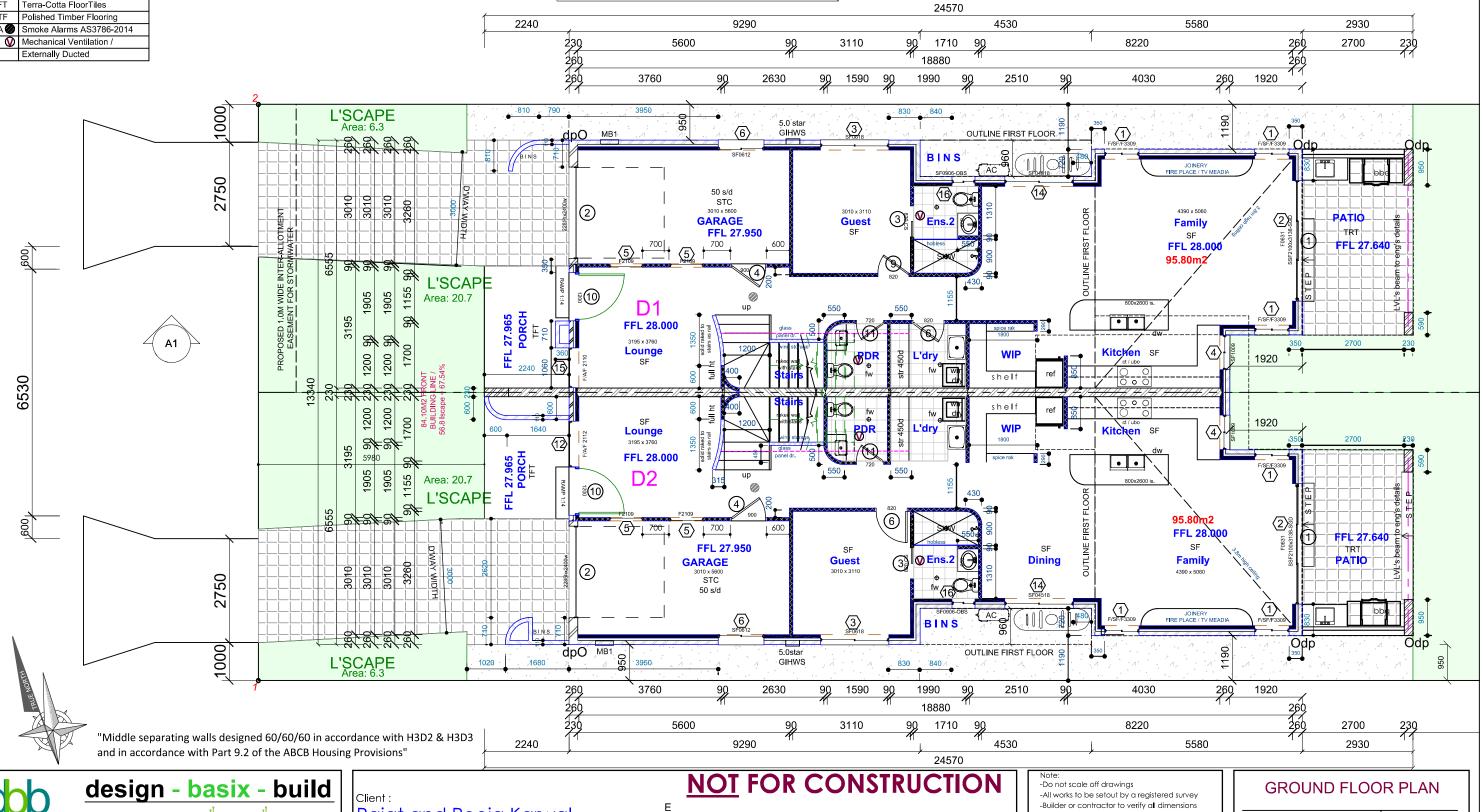
For Bathrooms / Laundry / WC that have No Natural Ventilation must demonstrate compliance with

A. Notation required to the Bathroom/Laundry/WC, in accordance Part H4D9 of NCC 2022 & Part 10.8 of Housing Provisions

Mechanical exhausts serving bathrooms or sanitary compartments (also called water closets) that are not provided with adequate natural ventilation via window or external door are required to: Be interlocked with the rooms light switch, and Include a run-on timer so the exhaust operates for 10 minutes after the switch is off

**REF. SERVICE PROTECTION REPORT** 

**SEWER CLEAR OF STRUCTURES** 



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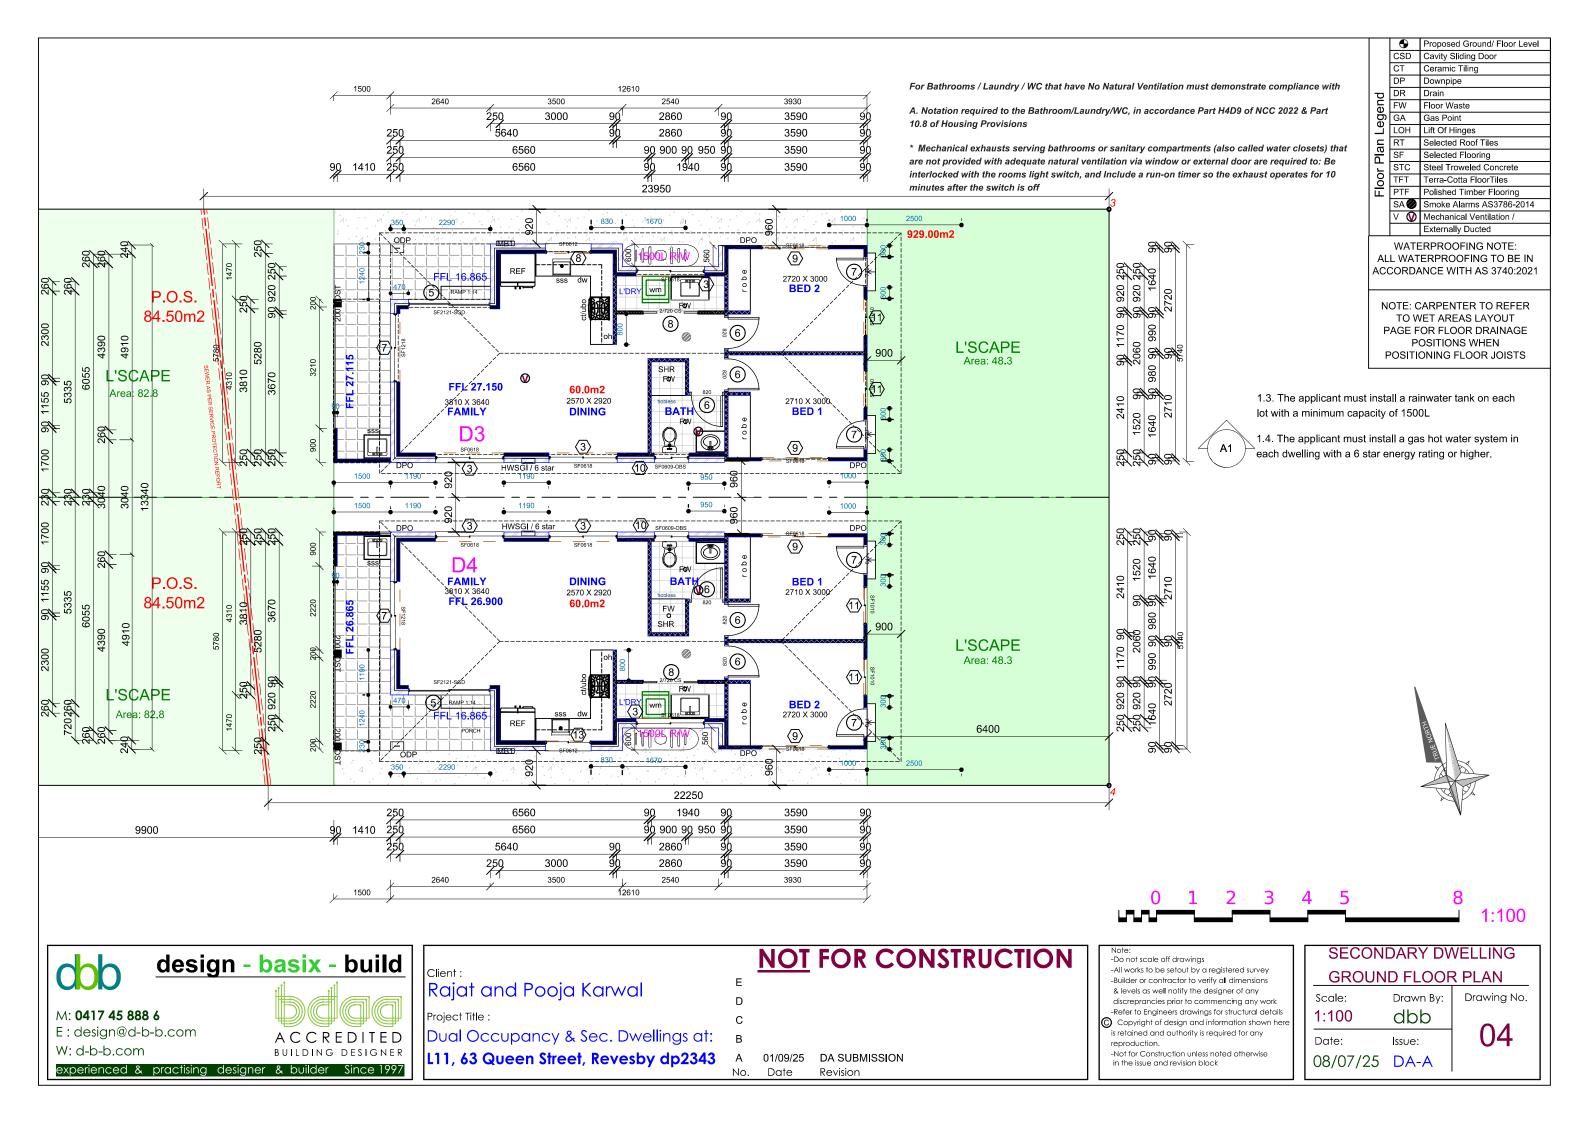
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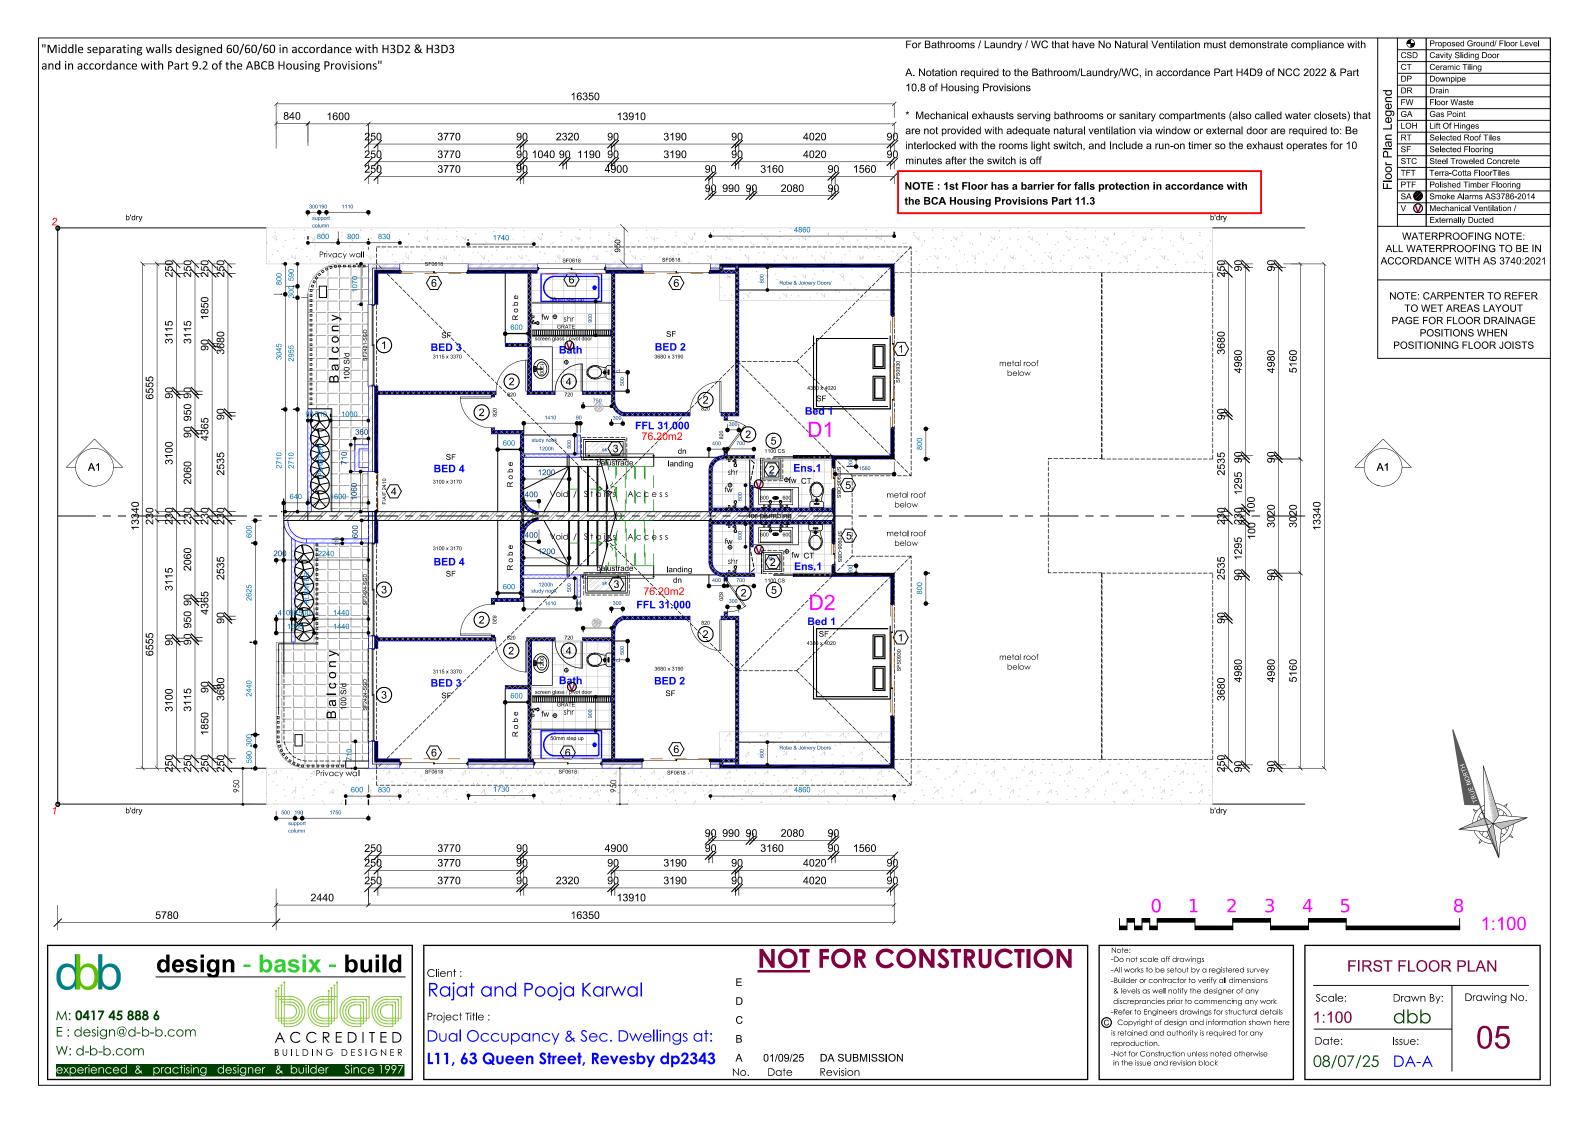
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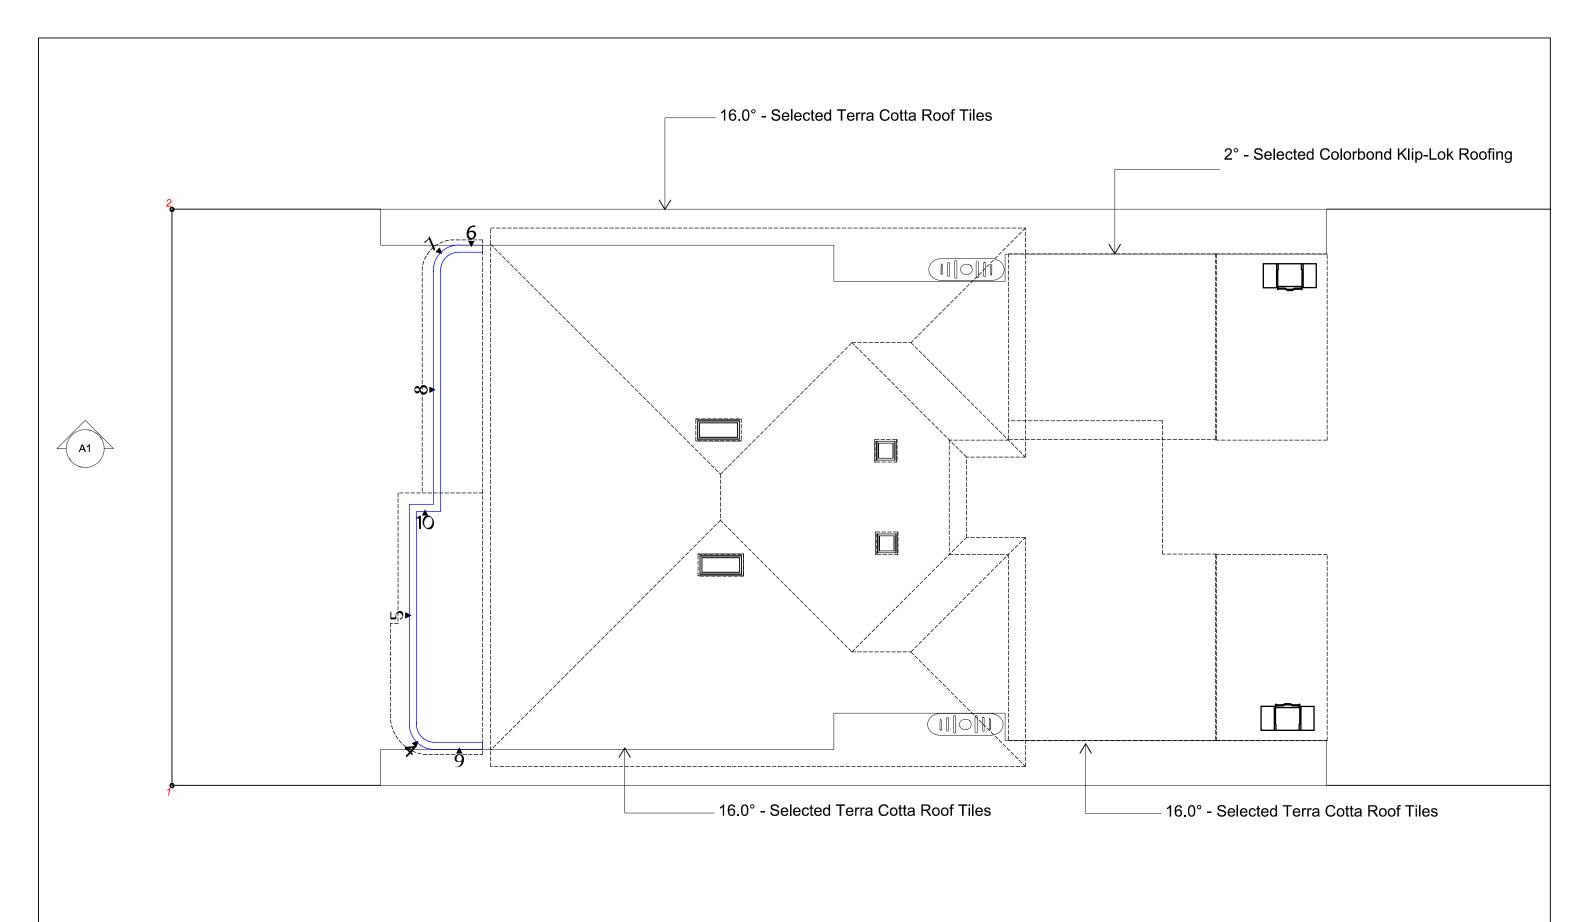
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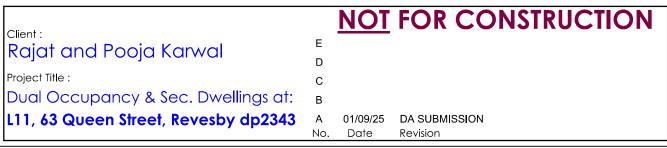
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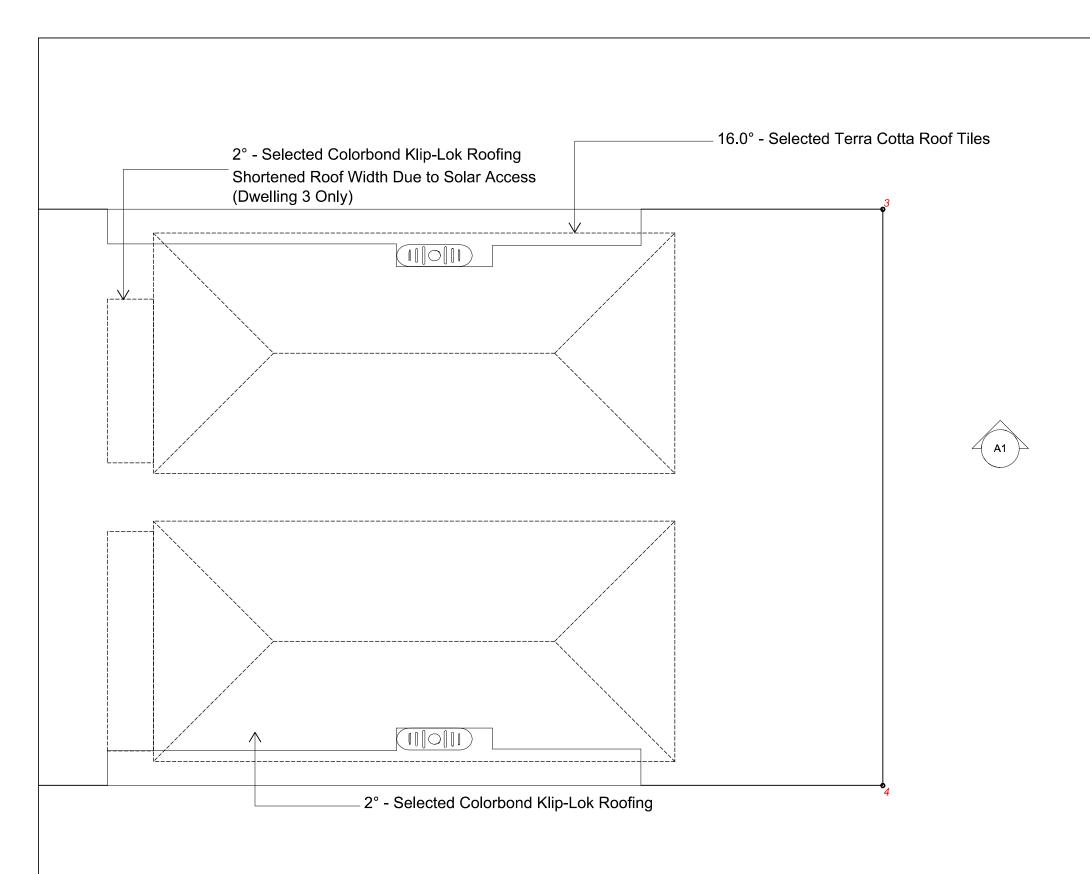
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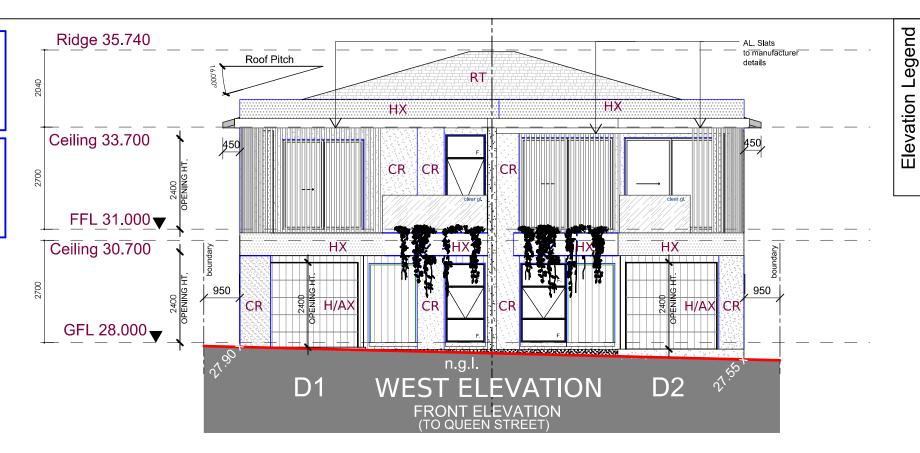
ROOF PLAN SEC. DWELLING					
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Date: 08/07/25	Issue: DA-A	06a			

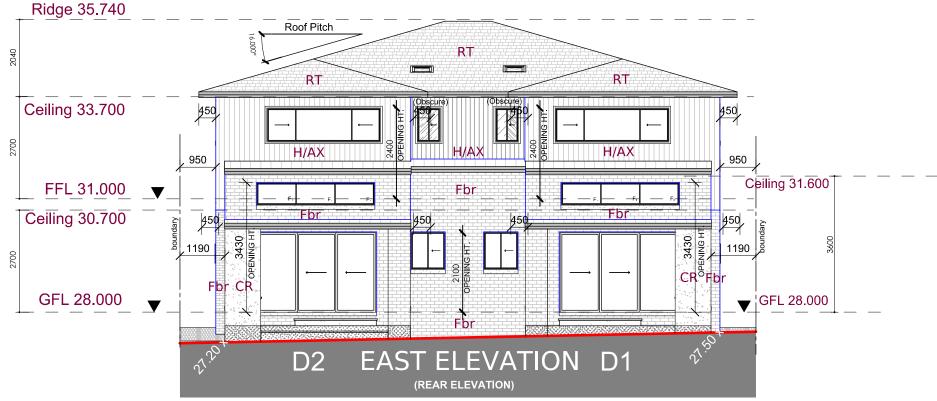


- window protection to bedrooms & to other rooms other than bedrooms to be in accordance to housing provisions 11.3.7 to 11.3.8 of NCC.

Eaves Lining / Vertical Lining / Non Combustible / Eaves Setback

Vertical lining eave separation H3D4 Part 9.2 & 9.3





"Middle separating walls designed 60/60/60 in accordance with H3D2 & H3D3 and in accordance with Part 9.2 of the ABCB Housing Provisions"



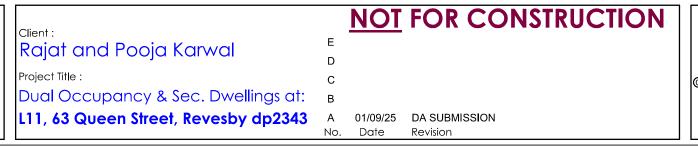
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2 3 4 5

(Obs)

CR

Fbr

НХ

RT

СВ

Obscure Glazing

Face brickwork

Commons Acrylic Rendi

Fibro-Acrylic Render

Hardies Axon Clad

Roof Tiles Selected

Colourbond Roofing

1:100

Drawing No.

07

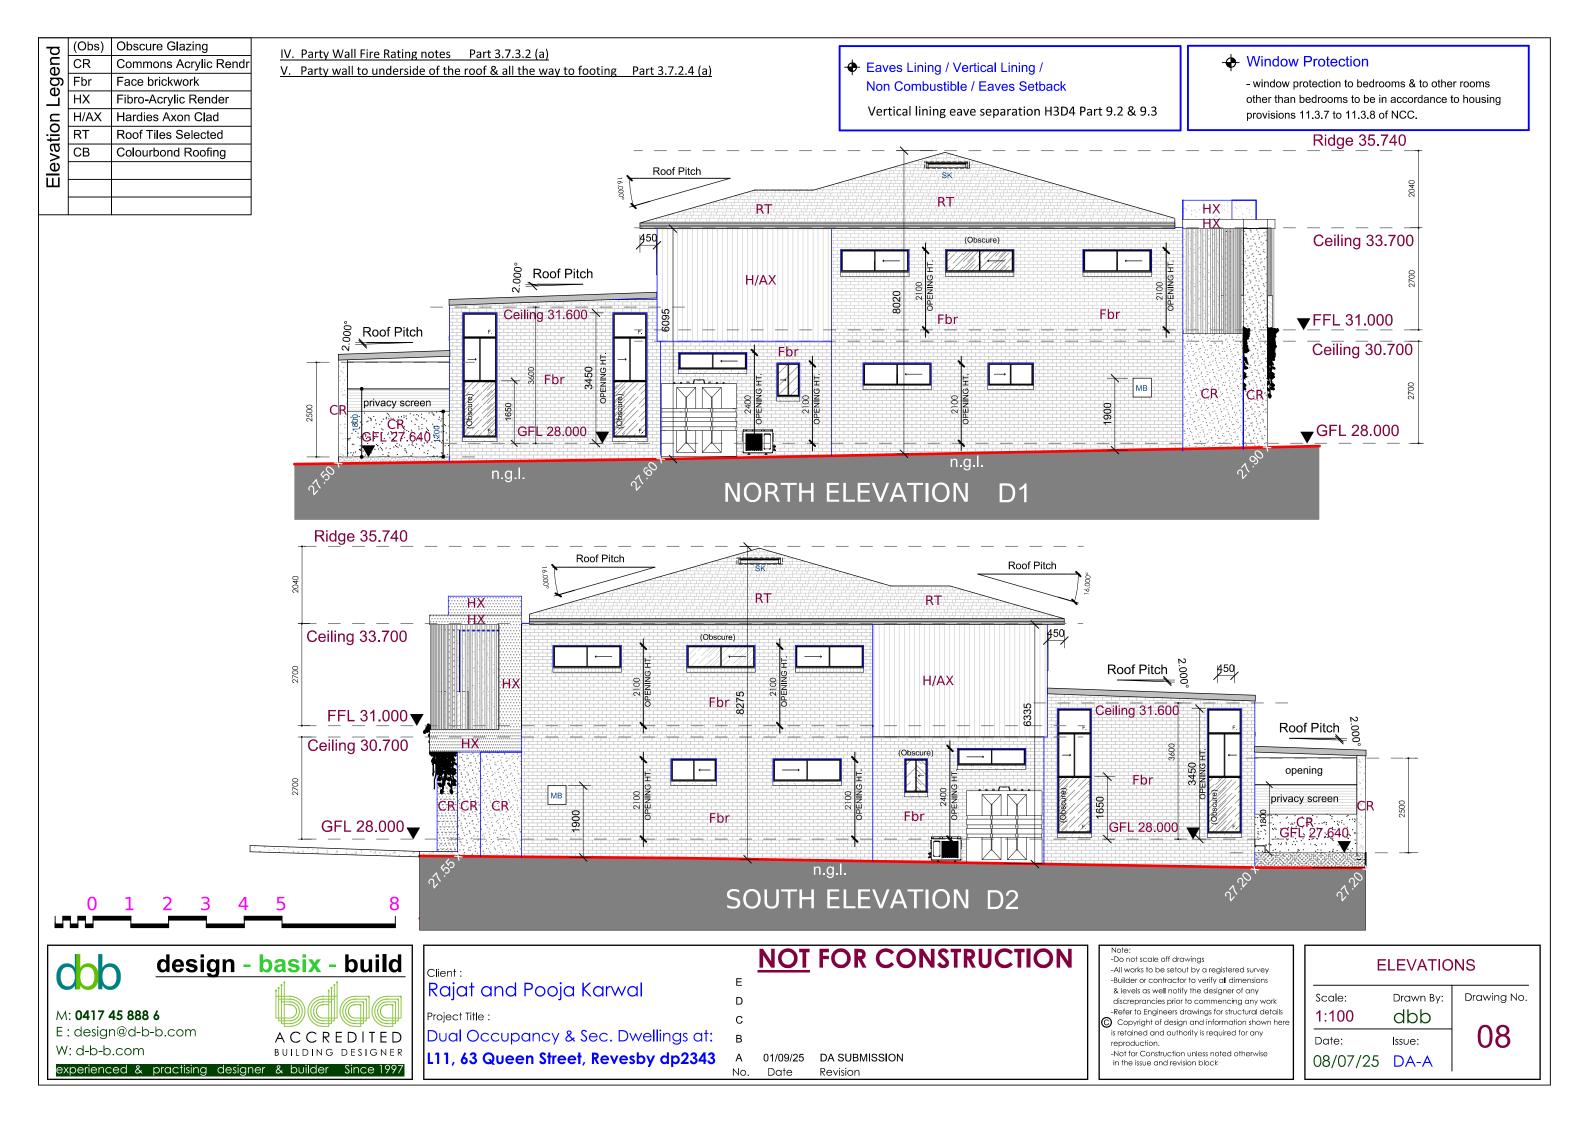
**8 REAR ELEVATION** 

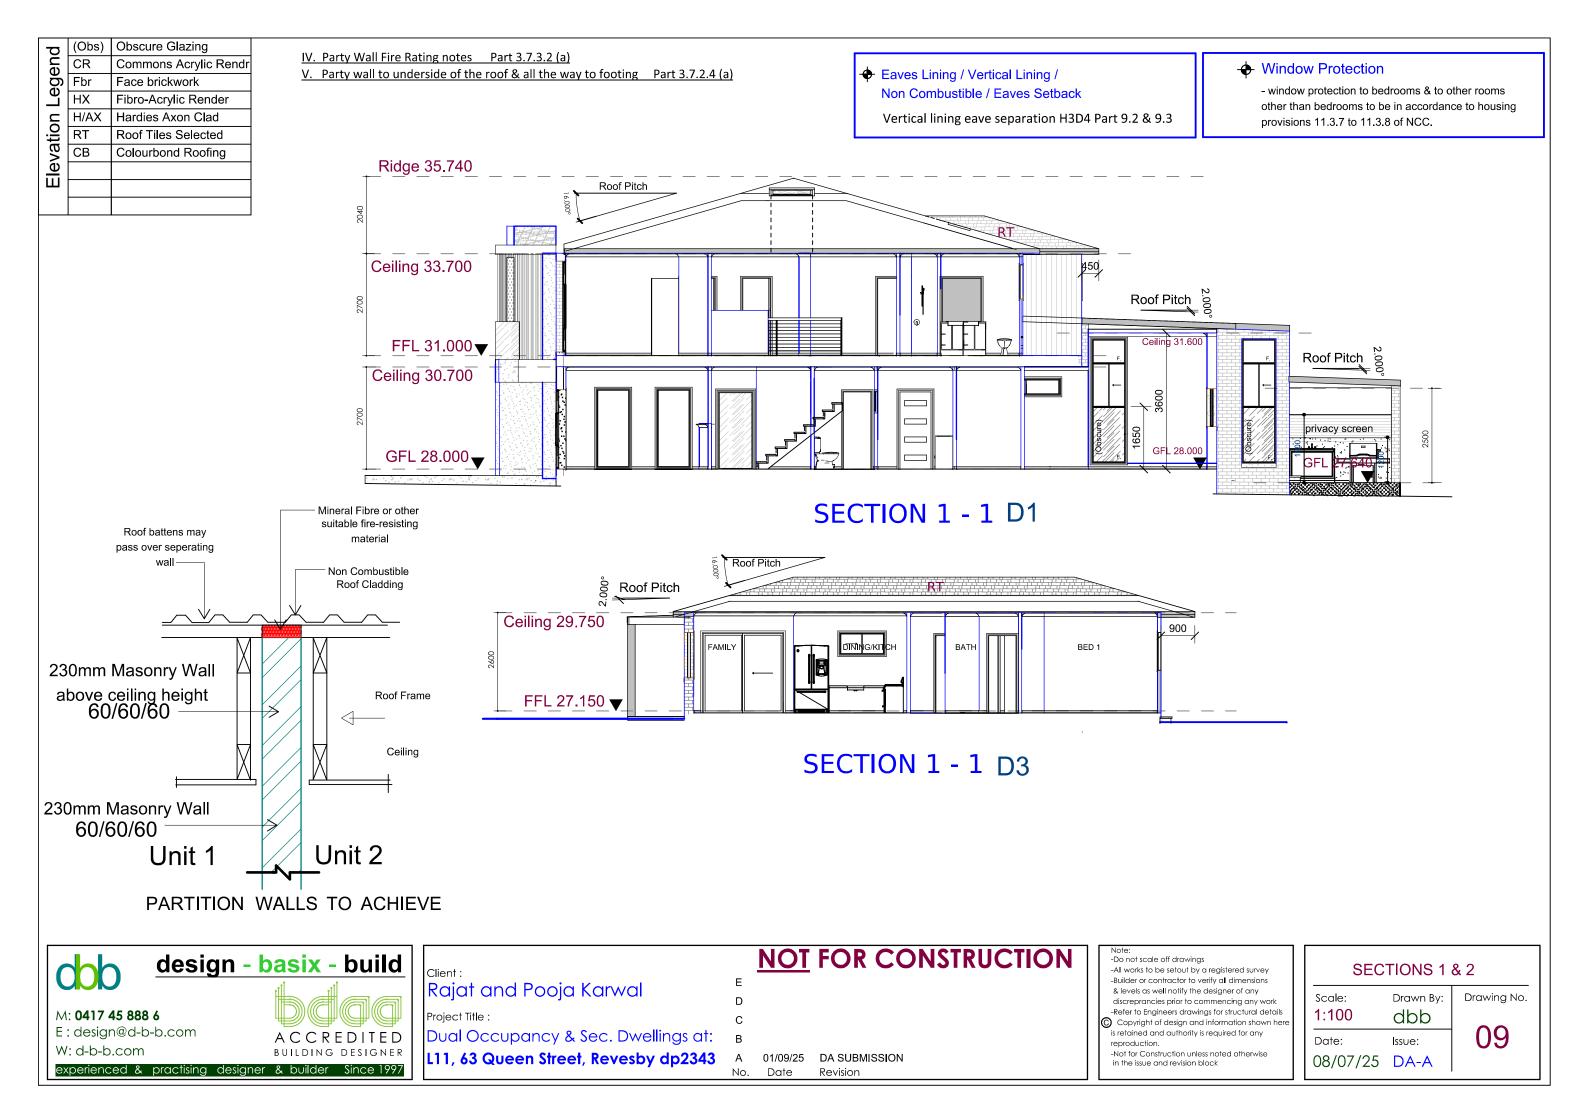
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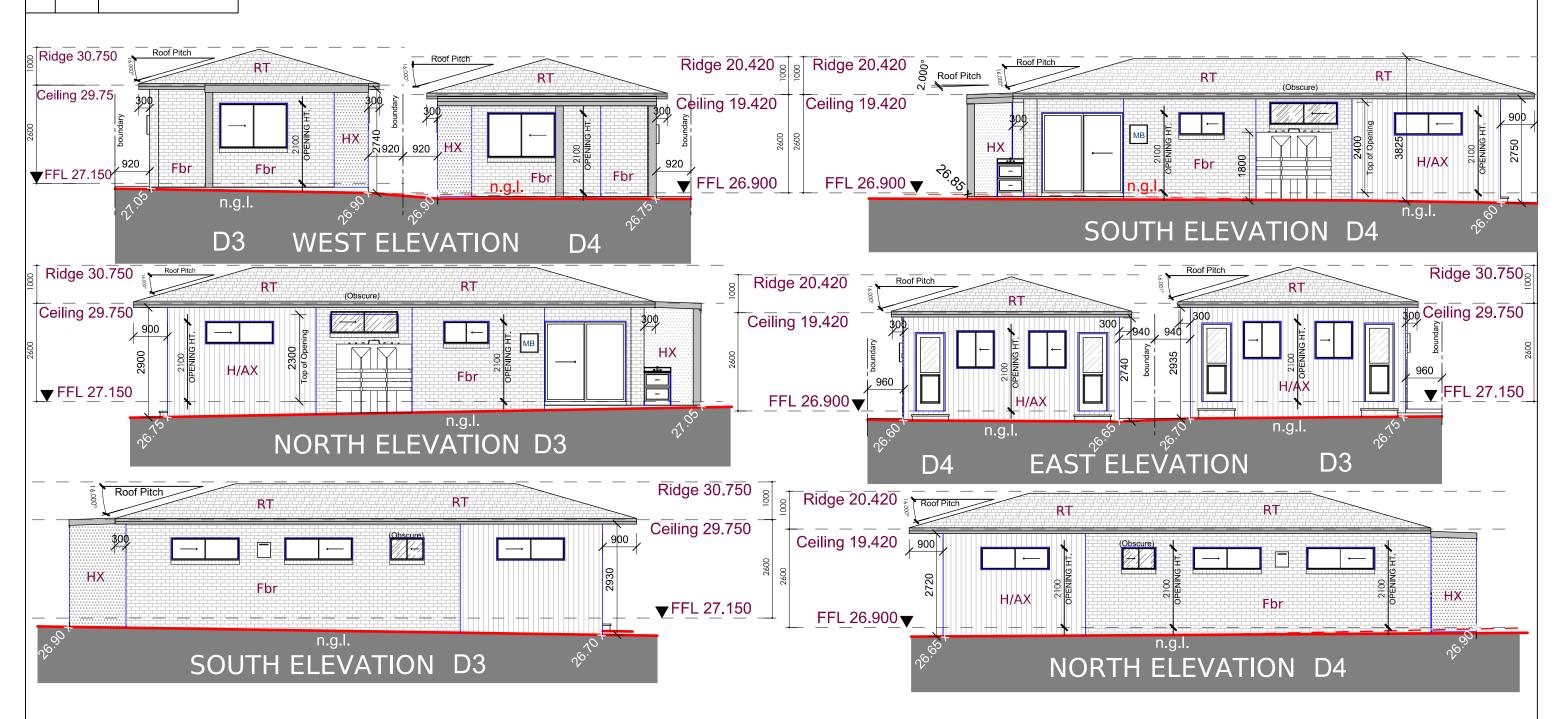
(Obs) Obscure Glazing
CR Commons Acrylic Rendre
Fbr Face brickwork
HX Fibro-Acrylic Render
H/AX Hardies Axon Clad
RT Roof Tiles Selected
CB Colourbond Roofing

Eaves Lining / Vertical Lining / Non Combustible / Eaves Setback

Vertical lining eave separation H3D4 Part 9.2 & 9.3

Window Protection

- window protection to bedrooms & to other rooms other than bedrooms to be in accordance to housing provisions 11.3.7 to 11.3.8 of NCC.





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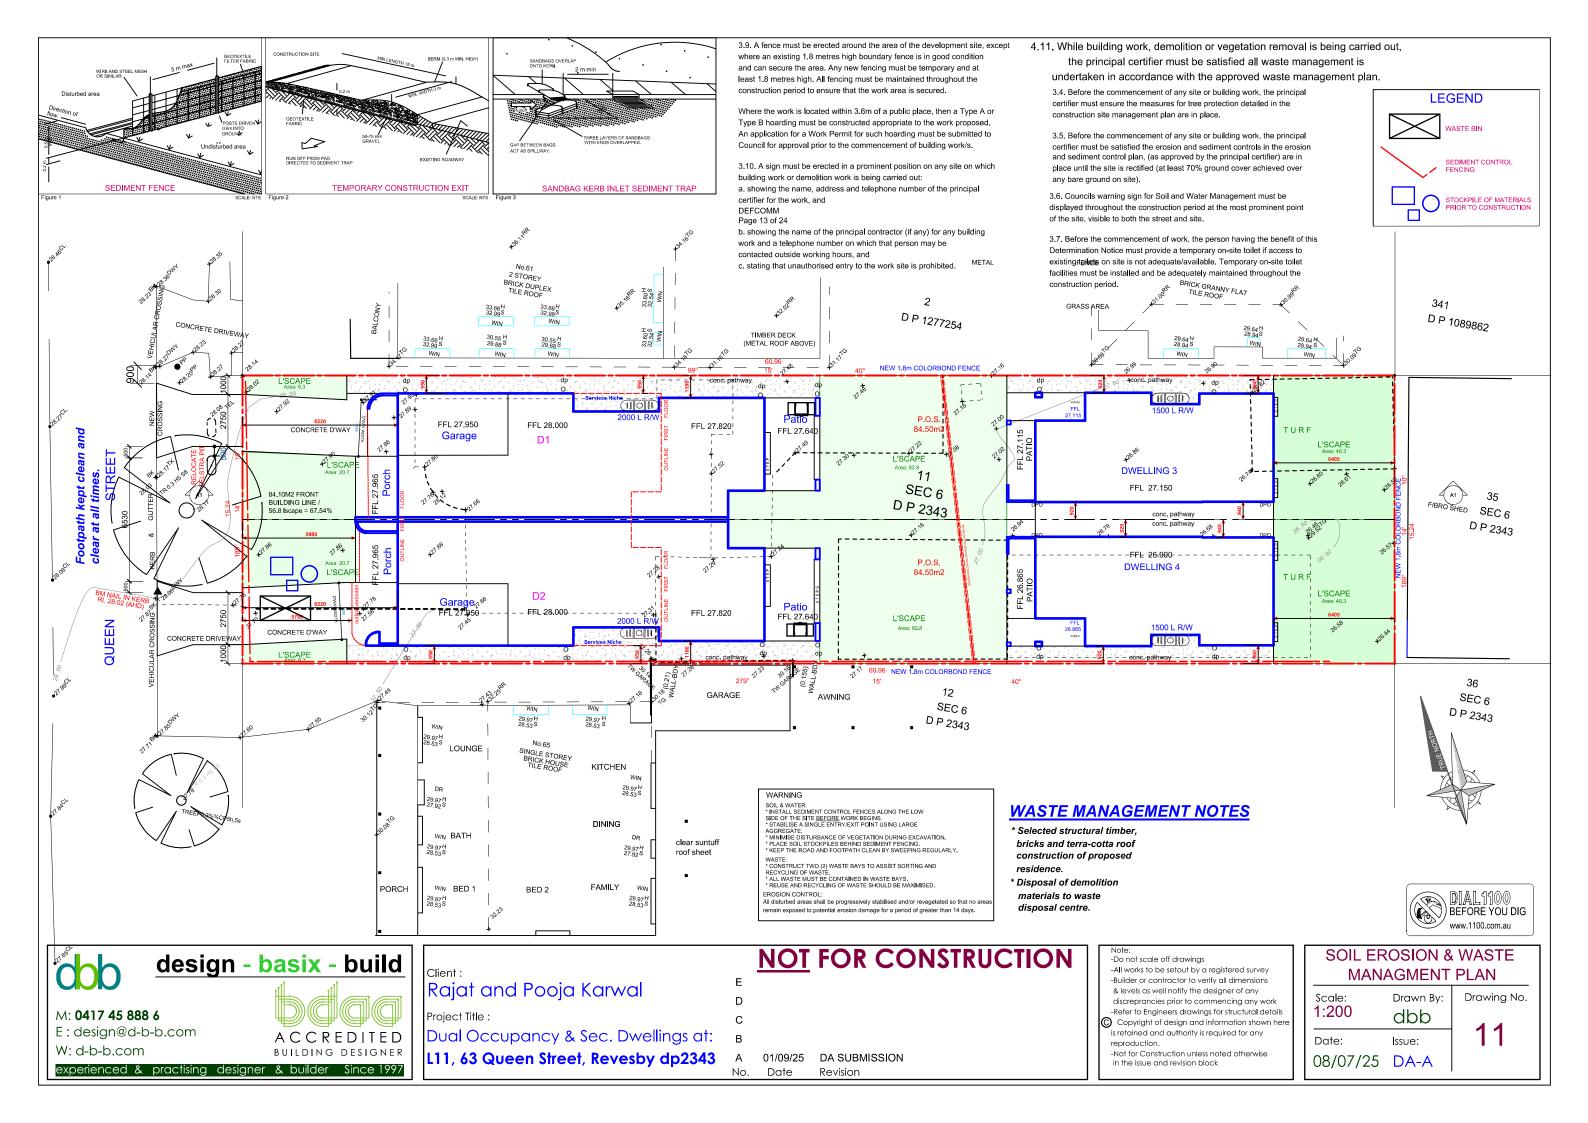
 SECONDARY DWELLINGS

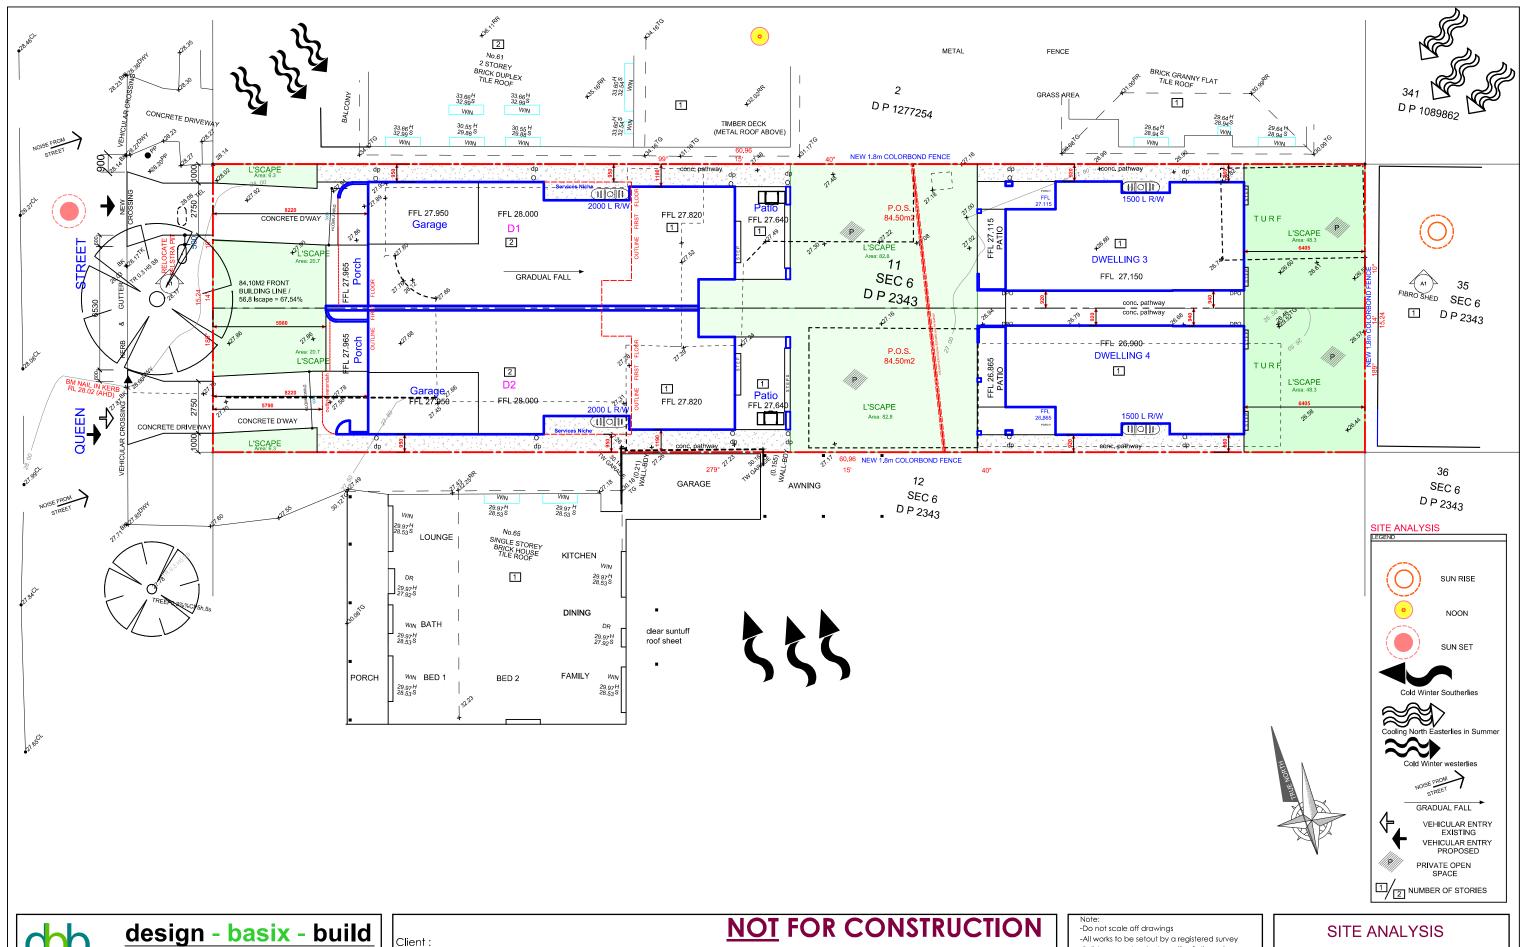
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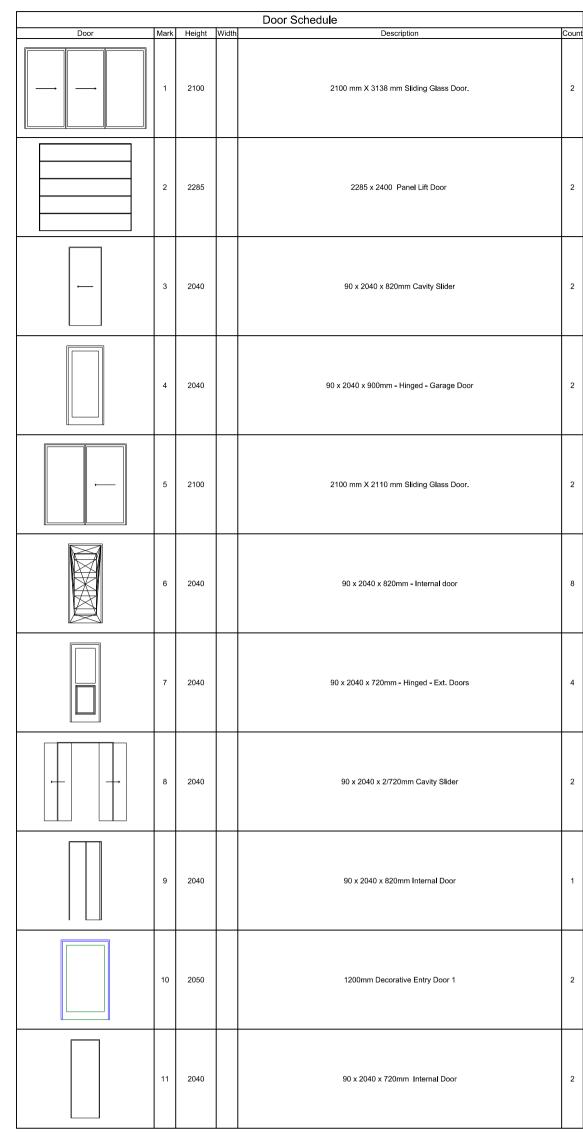
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Date: 08/07/25	Issue: DA-A	12			

	1	I	hee sa	Window Schedule	la .	
Elevation	Mark 1	Height 3000	910	Description  3300 X 910 mm Sliding Windows	Count 6	
	2	600	3138	600 X 3138 mm Fixed Windows	2	
—	3	600	1810	600 X 1810 mm Sliding Windows	8	
-	4	1000	910	1000 X 910 mm Sliding Windows	2	
	5	2100	900	2100 X 900 mm Fixed Windows (Internal glazing)	4	
	6	600	1210	600 X 1210 mm Sliding Windows	2	
	7	1200	1810	1200 X 1810 mm S <b>l</b> iding Windows	2	
	8	600	1210	600 X 1210 mm Silding Windows	1	
	9	600	1810	600 X 1810 mm Sliding Windows	4	
-	10	600	910	600 X 910 mm Sliding Windows	2	
-	11	1000	1010	1000 X 1010 mm S <b>li</b> ding Windows	4	
	12	900	1210	2050 X 1210 mm Awning Windows	1	
	13	600	1210	600 X 1210 mm Sliding Windows	1	
	14	450	1810	450 X 1810 mm Sliding Windows	2	
	15	2050	1050	2050 X 1050 mm Awning Windows	1	
-	16	900	610	900 X 610 mm Sliding Windows - OBS	2	



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**DUAL OCCUPANCY &** SECONDARY DWELLING GROUND FLOOR PLAN

Drawing No. Drawn By: Scale: 1:100(A2) dbb Date: Issue: 08/07/25 DA-A

**DWS** 

Window Schedule					
Elevation	Mark	Height	Width	Description	Count
	1	900	3010	900 X 3010 mm Sliding Windows	2
	2	600	600	600 mm X 600 mm Fixed Skylights	2
	3	1200	600	600 mm X 1200 mm Fixed Skylight	2
	4	2400	1050	2400 X 1050 mm Awning Windows	1
	5	900	610	900 X 610 mm Sliding Windows - OBS	2
	6	600	1810	600 X 1810 mm Sliding Windows	6

				Door Schedule	
Door	Mark	Height	Width	Description	Count
-	1	2400		2400 mm X 2110 mm Sliding Glass Door.	1
	2	2040		90 x 2040 x 820mm Internal Door	8
	3	2400		2400 mm X 2410 mm Sliding Glass Door.	2
	4	2040		90 x 2040 x 720mm Internal Door	2
<u></u>	5	2040		90 x 2040 x 1020mm Cavity Slider	2



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**DUAL OCCUPANCY** FIRST FLOOR PLAN

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Date: Issue: 08/07/25 DA-A

Drawing No.

# BASIX™Certificate

Building Sustainability Index

www.planningportal.nsw.gov.au/development-and-assessment/basix

## Single Dwelling 1

Certificate number: 1810190S

Water Commitments	

The applicant must install showerheads with a minimum rating of 4 star (> 4.5 but <= 6 L/min plus spray force and/or coverage tests) in all showers in the development.

The applicant must install a toilet flushing system with a minimum rating of 5 star in each toilet in the development.

The applicant must install taps with a minimum rating of 4 star in the kitchen in the development.

The applicant must install basin taps with a minimum rating of 4 star in each bathroom in the development.

## Alternative water

Rainwater tank

The applicant must install a rainwater tank of at least 2000 litres on the site. This rainwater tank must meet, and be installed in accordance with, the requirements of all applicable regulatory authorities.

The applicant must configure the rainwater tank to collect rain runoff from at least 165.6 square metres of the roof area of the development (excluding the area of the roof which drains to any stormwater tank or private dam).

The applicant must connect the rainwater tank to:

at least one outdoor tap in the development (Note: NSW Health does not recommend that rainwater be used for human consumption in areas with potable water supply.)

Construction	Area - m²	Additional insulation required	Options to address thermal bridging	Other specifications
floor - concrete slab on ground, conventional slab.	165.6	nil;not specified	nil	
floor - above habitable rooms or mezzanine, particle board; frame: timber - H2 treated softwood.	21.25	nil;fibreglass batts or roll	nil	
floor - suspended floor above garage, concrete - suspended; frame: timber - H2 treated softwood.	12.45	nil;fibreglass batts or roll	nil	

Construction	Area - m²	Additional insulation required	Options to address thermal bridging	Other specifications
garage floor - concrete slab on ground, 60% cement substitute.	16.8	none	nil	
external wall: brick veneer; frame: timber - H2 treated softwood.	443	2.94 (or 3.50 including construction); fibreglass batts or roll	nil	wall colour: Medium (solar absorptance 0.48-0.7)
external wall: framed (fibre cement sheet or boards); frame: timber - H2 treated softwood.	120	3.00 (or 3.50 including construction); fibreglass batts or roll	nil	wall colour: Medium (solar absorptance 0.48-0.7)
external garage wall: brick veneer; frame: timber - H2 treated softwood.	19.32	fibreglass batts or roll	nil	
internal wall shared with garage: plasterboard; frame: timber - H2 treated softwood.	22.31	nil;fibreglass batts or roll	nil	
internal wall: plasterboard; frame: timber - H2 treated softwood.	205	fibreglass batts or roll	nil	
ceiling and roof - flat ceiling / pitched roof, framed - metal roof, timber - H2 treated softwood.	165.6	ceiling: 4 (up), roof: foil/ sarking ;ceiling: fibreglass batts or roll; roof: foil/sarking.	nil	roof space ventilation: unventilated; roof colour: light (solar absorptance < 0.38); ceilir area fully insulated

Note	Insulation specified in this Certificate must be installed in accordance with the ABCB Housing Provisions (Part 13.2.2) of the National Construction Code.

Note • If the additional ceiling insulation listed in the table above is greater than R3.0, refer to the ABCB Housing Provisions (Part 13.2.3 (6)) of the National Construction Code.

Note • In some climate zones, insulation should be installed with due consideration of condensation and associated interaction with adjoining building materials. Note • Thermal breaks must be installed in metal framed walls and applicable roofs in accordance with the ABCB Housing Provisions of the National Construction Code.

# Ceiling fans

The applicant must install at least one ceiling fan in at least one daytime habitable space, such as living room.

The minimum number and diameter of ceiling fans in a daytime habitable space must be installed in accordance with the ABCB Housing Provisions (Part 13.5.2) of the National Construction Code

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# **Energy Commitments**

The applicant must install a window and/or skylight in 3 bathroom(s)/toilet(s) in the development for natural lighting.

# Other

The applicant must install a gas cooktop & electric oven in the kitchen of the dwelling.

Glazed window/door no.	Maximum height (mm)	Maximum width (mm)	Frame and glass	Shading device	Overshadowing	
North facing						
W06 Garage	600.00	1210.00	aluminium, single glazed (U- value: <=5.0, SHGC: 0.74 - 0.90)	none	1-2 m high, <1.5 m away	
W03 Guest	600.00	1810.00	aluminium, single glazed (U- value: <=5.0, SHGC: 0.74 - 0.90)	none	1-2 m high, <1.5 m away	
W16 Ens. 2	900.00	610.00	aluminium, single glazed (U- value: <=5.0, SHGC: 0.74 - 0.90)	none	2-4 m high, 2 m away	

Glazed window/door no.	Maximum height (mm)	Maximum width (mm)	Frame and glass specification	Shading device (Dimension within 10%)	Overshadowing
W014 Dining	450.00	1810.00	aluminium, single glazed (U- value: <=5.0, SHGC: 0.74 - 0.90)	none	2-4 m high, 2 m away
W01 Family	3300.00	910.00	aluminium, single glazed (U- value: <=5.0, SHGC: 0.74 - 0.90)	none	1-2 m high, <1.5 m away
W01 Family	3300,00	910.00	aluminium, single glazed (U- value: <=5.0, SHGC: 0.74 - 0.90)	none	1-2 m high, <1.5 m away
W06 Bed 3	600.00	1810.00	aluminium, single glazed (U- value: <=5.0, SHGC: 0.74 - 0.90)	eave 580 mm, 343 mm above head of window or glazed door	2-4 m high, 2 m away
W06 Bath	600.00	1810.00	aluminium, single glazed (U- value: <=5.0, SHGC: 0.74 - 0.90)	eave 580 mm, 343 mm above head of window or glazed door	2-4 m high, 2 m away
W06 Bed 2	600.00	1810.00	aluminium, single glazed (U- value: <=5.0, SHGC: 0.74 - 0.90)	eave 580 mm, 343 mm above head of window or glazed door	2-4 m high, 2 m away
East facing					
W02 Family	600.00	3138.00	aluminium, single glazed (U- value: <=5.0, SHGC: 0.74 - 0.90)	eave 580 mm, 343 mm above head of window or glazed door	not overshadowed
Door 1 Family	2100.00	3138.00	aluminium, single glazed (U- value: <=5.0, SHGC: 0.74 - 0.90)	verandah 2940 mm, 2200 mm above base of window or glazed door	2-4 m high, 8-12 m away
W04 Kitchen	1000.00	910.00	aluminium, single glazed (U- value: <=5.0, SHGC: 0.74 - 0.90)	eave 580 mm, 343 mm above head of window or glazed door	not overshadowed
W01 Bed 1	900,00	3010.00	aluminium, single glazed (U- value: <=5.0, SHGC: 0.74 - 0.90)	eave 580 mm, 343 mm above head of window or glazed door	not overshadowed
W05 Ens. 1	900.00	610.00	aluminium, single glazed (U- value: <=5.0, SHGC: 0.74 - 0.90)	eave 580 mm, 343 mm above head of window or glazed door	not overshadowed

Glazed window/door no.	Maximum height (mm)	Maximum width (mm)	Frame and glass specification	Shading device (Dimension within 10%)	Overshadowing
South facing					
W01 Family	3300.00	910.00	aluminium, single glazed (U- value: <=5.0, SHGC: 0.74 - 0.90)	none	1-2 m high, <1.5 m away
West facing					
W15 Lounge	2050.00	1050.00	aluminium, single glazed (U- value: <=5.0, SHGC: 0.74 - 0.90)	solid overhang 2240 mm, 200 mm above head of window or glazed door	not overshadowed
Door1 Bed 3	2400.00	2110.00	aluminium, single glazed (U- value: <=5.0, SHGC: 0.74 - 0.90)	verandah 1600 mm, 2675 mm above base of window or glazed door	not overshadowed
W04 Bed 4	2400.00	1050.00	aluminium, single glazed (U- value: <=5.0, SHGC: 0.74 - 0.90)	verandah 1000 mm, 2575 mm above base of window or glazed door	not overshadowed

# **Energy Commitments**

The applicant must install the following hot water system in the development, or a system with a higher energy rating: gas instantaneous with a performance of 5 stars.

The applicant must install the following cooling system, or a system with a higher energy rating, in at least 1 living area: 1-phase airconditioning - ducted; Energy rating: 6 star (average zone)

The applicant must install the following cooling system, or a system with a higher energy rating, in at least 1 bedroom: 1-phase airconditioning - ducted; Energy rating: 6 star (average zone)

The applicant must install the following heating system, or a system with a higher energy rating, in at least 1 living area: 1-phase airconditioning - ducted; Energy rating; 6 star (average zone)

The applicant must install the following heating system, or a system with a higher energy rating, in at least 1 bedroom: 1-phase airconditioning - ducted; Energy rating; 6 star (average zone)

# Ventilation

The applicant must install the following exhaust systems in the development:

At least 1 Bathroom: individual fan, ducted to facade or roof; Operation control: manual switch on/off

Kitchen: individual fan, open to façade; Operation control: manual switch on/of

Laundry: individual fan, ducted to façade or roof; Operation control: manual switch on/off

### Artificial lighting

The applicant must ensure that a minimum of 80% of light fixtures are fitted with fluorescent, compact fluorescent, or light-emitting diode (LED) lamps.

### Natural lighting

The applicant must install a window and/or skylight in the kitchen of the dwelling for natural lighting.

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Rajat and Pooja Karwal

Project Title :

Dual Occupancy & Sec. Dwellings at:

L11, 63 Queen Street, Revesby dp2343

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A 01/09/25 DA SUBMISSION No. Date

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**ENERGY EFFICIENCY NOTES** & GENERAL NOTES Scale: Drawing No. Drawn By: NTS dbb en.eff1 Date: Issue:

08/07/25 DA-A

# BASIX™Certificate

The applicant must connect the rainwater tank to:

Building Sustainability Index

## Single Dwelling 2

Certificate number: 1810192S

Water Commitments	
Fixtures	
The applicant must install showerheads with a minimum rating of 4 star (> 4.5 but <= 6 L/min plus spray force and/or coverage tests) all showers in the development.	in
The applicant must install a toilet flushing system with a minimum rating of 5 star in each toilet in the development,	
The applicant must install taps with a minimum rating of 4 star in the kitchen in the development,	1
The applicant must install basin taps with a minimum rating of 4 star in each bathroom in the development.	
Alternative water	
Rainwater tank	
The applicant must install a rainwater tank of at least 2000 litres on the site. This rainwater tank must meet, and be installed in accordance with, the requirements of all applicable regulatory authorities.	
The applicant must configure the rainwater tank to collect rain runoff from at least 165.6 square metres of the roof area of the	T

Construction	Area - m²	Additional insulation required
floor - concrete slab on ground, conventional slab.	185.6	nil;not specified
floor - above habitable rooms or mezzanine, particle board; frame: timber - H2 treated softwood	21.25	nil;fibreglass batts or roll
floor - suspended floor above garage, concrete - suspended; frame: timber - H2 treated softwood.	12.45	nil;fibreglass batts or roll

at least one outdoor tap in the development (Note: NSW Health does not recommend that rainwater be used for human consumption in areas with potable water supply.)

Construction	Area - m²	Additional insulation required	Options to address thermal bridging	Other specifications	
garage floor - concrete slab on ground, 60% cement substitute.	16.8	none	nil		
external wall: brick veneer; frame: timber - H2 treated softwood.			wood. construction);fibreglass batts or absorptance 0.48-0		wall colour: Medium (solar absorptance 0.48-0.7)
external wall: framed (fibre cement sheet or boards); frame: timber - H2 treated softwood	120	3.00 (or 3.50 including construction); fibreglass batts or roll	nil	wall colour: Medium (solar absorptance 0.48-0.7)	
external garage wall: brick veneer; frame: timber - H2 treated softwood.	19.32	fibreglass batts or roll	nil		
internal wall shared with garage: plasterboard; frame: timber - H2 treated softwood.	22.31	nil;fibreglass batts or roll	nil		
internal wall: plasterboard; frame: timber - H2 treated softwood.	205	fibreglass batts or roll	nil		
ceiling and roof - flat ceiling / pitched roof, framed - metal roof, timber - H2 treated softwood.	185.6	ceiling: 4 (up), roof: foil/ sarking ;ceiling: fibreglass batts or roll; roof: foil/sarking.	nil	roof space ventilation: unventilated; roof colour: light (solar absorptance < 0.38); ceiling area fully insulated	

ı	Note	<ul> <li>Insulation specified in this Certificate must be installed in accordance with the ABCB Housing Provisions (Part 13.2.2) of the National Construction Code.</li> </ul>
	Note	• If the additional ceiling insulation listed in the table above is greater than R3.0, refer to the ABCB Housing Provisions (Part 13.2.3 (6)) of the National Construction Code.
	Note	In some climate zones, insulation should be installed with due consideration of condensation and associated interaction with adjoining building materials.
	Note	Thermal breaks must be installed in metal framed walls and applicable roofs in accordance with the ABCB Housing Provisions of the National Construction Code.

The applicant must install at least one ceiling fan in at least one daytime habitable space, such as living room.

The minimum number and diameter of ceiling fans in a daytime habitable space must be installed in accordance with the ABCB Housing Provisions (Part 13.5.2) of the National Construction Code.

The applicant must install a window and/or skylight in 3 bathroom(s)/toilet(s) in the development for natural lighting.

# Other

The applicant must install a gas cooktop & electric oven in the kitchen of the dwelling.

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Glazed window/door no.	Maximum height (mm)	Maximum width (mm)	Frame and glass specification	Shading device (Dimension within 10%)	Overshadowing
North facing					
W01 Family	3300.00	910.00	aluminium, single glazed (U- value: <=5.0, SHGC: 0.74 - 0.90)	none	1-2 m high, <1.5 m away
East facing					
W02 Family	600.00	3138.00	aluminium, single glazed (U- value: <=5.0, SHGC: 0.74 - 0.90)	eave 580 mm, 343 mm above head of window or glazed door	not overshadowed

Glazed window/door no.	Maximum height (mm)	Maximum width (mm)	Frame and glass specification	Shading device (Dimension within 10%)	Overshadowing
Door 1 Family	2100.00	3138.00	aluminium, single glazed (U- value: <=5.0, SHGC: 0.74 - 0.90)	verandah 2940 mm, 2200 mm above base of window or glazed door	not overshadowed
W04 Kitchen	1000.00	910,00	aluminium, single glazed (U- value: <=5.0, SHGC: 0.74 - 0.90)	eave 580 mm, 343 mm above head of window or glazed door	not overshadowed
W01 Bed 1	900.00	3010.00	aluminium, single glazed (U- value: <=5.0, SHGC: 0.74 - 0.90)	eave 580 mm, 343 mm above head of window or glazed door	not overshadowed
W05 Ens.1	900.00	610.00	aluminium, single glazed (U- value: <=5.0, SHGC: 0.74 - 0.90)	eave 580 mm, 343 mm above head of window or glazed door	not overshadowed
South facing					
W06 Garage	600.00	1210.00	aluminium, single glazed (U- value: <=5.0, SHGC: 0.74 - 0.90)	none	1-2 m high, <1.5 m awa
W03 Guest	600.00	1810.00	aluminium, single glazed (U- value: <=5.0, SHGC: 0.74 - 0.90)	none	1-2 m high, <1.5 m away
W16 Ens.2	900.00	610.00	aluminium, single glazed (U- value: <=5.0, SHGC: 0.74 - 0.90)	solid overhang 900 mm, 575 mm above head of window or glazed door	2-4 m high, 2 m away
W14 Dining	450.00	1810.00	aluminium, single glazed (U- value: <=5.0, SHGC: 0.74 - 0.90)	solid overhang 900 mm, 300 mm above head of window or glazed door	2-4 m high, 2 m away
W01 Family	3300.00	910,00	aluminium, single glazed (U- value: <=5.0, SHGC: 0.74 - 0.90)	none	1-2 m high, <1.5 m away
W01 Family	3300.00	910.00	aluminium, single glazed (U- value: <=5.0, SHGC: 0.74 - 0.90)	none	1-2 m high, <1.5 m away
W06 Bed 3	600.00	1810.00	aluminium, single glazed (U- value: <=5.0, SHGC: 0.74 - 0.90)	eave 580 mm, 343 mm above head of window or glazed door	2-4 m high, 2-5 m away

Glazed window/door no.	Maximum height (mm)	Maximum width (mm)	Frame and glass specification	Shading device (Dimension within 10%)	Overshadowing	
W06 Bath	600.00	1810.00	aluminium, single glazed (U- value: <=5.0, SHGC: 0.74 - 0.90)	eave 580 mm, 343 mm above head of window or glazed door	2-4 m high, 2-5 m away	
W06 Bed 2	600.00	1810.00	aluminium, single glazed (U- value: <=5.0, SHGC: 0.74 - 0.90)	eave 580 mm, 343 mm above head of window or glazed door	2-4 m high, 2 m away	
West facing						
W12 Lounge	2050.00	1210.00	aluminium, single glazed (U- value: <=5.0, SHGC: 0.74 - 0.90)	solid overhang 2240 mm, 200 mm above head of window or glazed door	not overshadowed	
Door 3 Bed 4	2400.00	2410.00	aluminium, single glazed (U- value: <=5.0, SHGC: 0.74 - 0.90)	verandah 1600 mm, 2450 mm above base of window or glazed door	not overshadowed	
Door 3 Bed 3	2400.00	2410.00	aluminium, single glazed (U- value: <=5.0, SHGC: 0.74 - 0.90)	verandah 1600 mm, 2450 mm above base of window or glazed door	not overshadowed	

## **Energy Commitments**

### Hot water

The applicant must install the following hot water system in the development, or a system with a higher energy rating: gas instantaneous with a performance of 5 stars.

## Cooling system

The applicant must install the following cooling system, or a system with a higher energy rating, in at least 1 living area: 1-phase airconditioning - ducted; Energy rating: 6 star (average zone)

The applicant must install the following cooling system, or a system with a higher energy rating, in at least 1 bedroom: 1-phase airconditioning - ducted; Energy rating: 6 star (average zone)

The applicant must install the following heating system, or a system with a higher energy rating, in at least 1 living area: 1-phase airconditioning - ducted; Energy rating: 6 star (average zone)

The applicant must install the following heating system, or a system with a higher energy rating, in at least 1 bedroom: 1-phase airconditioning - ducted; Energy rating: 6 star (average zone)

### Ventilation

The applicant must install the following exhaust systems in the development:

At least 1 Bathroom: individual fan, ducted to façade or roof; Operation control: manual switch on/off

Kitchen: individual fan. open to facade: Operation control: manual switch on/off

Laundry: individual fan, ducted to façade or roof; Operation control: manual switch on/off

The applicant must ensure that a minimum of 80% of light fixtures are fitted with fluorescent, compact fluorescent, or light-emitting-diode (LED) lamps.

## Natural lighting

The applicant must install a window and/or skylight in the kitchen of the dwelling for natural lighting.

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ACCREDITED W: d-b-b.com BUILDING DESIGNER

Rajat and Pooja Karwal

Dual Occupancy & Sec. Dwellings at:

L11, 63 Queen Street, Revesby dp2343

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**ENERGY EFFICIENCY NOTES** & GENERAL NOTES Scale: NTS Date:

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# BASIX™Certificate

Building Sustainability Index

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# Single Dwelling 3

Certificate number: 1810184S

## **Water Commitments**

### Fixtures

The applicant must install showerheads with a minimum rating of 4 star (> 4.5 but <= 6 L/min plus spray force and/or coverage tests) in

The applicant must install a toilet flushing system with a minimum rating of 6 star in each toilet in the development.

The applicant must install taps with a minimum rating of 6 star in the kitchen in the development.

The applicant must install basin taps with a minimum rating of 5 star in each bathroom in the development.

### Alternative water

The applicant must install a rainwater tank of at least 1500 litres on the site. This rainwater tank must meet, and be installed in accordance with, the requirements of all applicable regulatory authorities

The applicant must configure the rainwater tank to collect rain runoff from at least 165.6 square metres of the roof area of the development (excluding the area of the roof which drains to any stormwater tank or private dam).

The applicant must connect the rainwater tank to:

 at least one outdoor tap in the development (Note: NSW Health does not recommend that rainwater be used for human consumption in areas with potable water supply.)

Construction	Area - m²	Additional insulation required	Options to address thermal bridging	Other specifications
floor - concrete slab on ground, conventional slab.	60.2	nil;not specified	nil	
external wall: brick veneer; frame: timber - H2 treated softwood.	all external walls	2.94 (or 3.50 including construction); fibreglass batts or roll	nil	wall colour: Medium (solar absorptance 0.48-0.7)
internal wall: plasterboard; frame: timber - H2 treated softwood.	68.5	fibreglass batts or roll	nil	

Construction	Area - m²	Additional insulation required	Options to address thermal bridging	Other specifications
ceiling and roof - flat ceiling / pitched roof, framed - metal roof, timber - H2 treated softwood.	94.8	ceiling: 4 (up), roof: foil/ sarking ;ceiling: fibreglass batts or roll; roof: foil/sarking.	nil	roof space ventilation: unventilated; roof colour: light (solar absorptance < 0.38); ceiling area fully insulated

Note	Insulation specified in this Certificate must be installed in accordance with the ABCB Housing Provisions (Part 13.2.2) of the National Construction Code.
Note	If the additional ceiling insulation listed in the table above is greater than R3.0, refer to the ABCB Housing Provisions (Part 13.2.3 (6)) of the National Construction Code.
Note	In some climate zones, insulation should be installed with due consideration of condensation and associated interaction with adjoining building materials.
Note	Thermal breaks must be installed in metal framed walls and applicable roofs in accordance with the ABCB Housing Provisions of the National Construction Code.

## Thermal Performance and Materials commitments

Ceiling fans

The applicant must install at least one ceiling fan in at least one daytime habitable space, such as living room.

The minimum number and diameter of ceiling fans in a daytime habitable space must be installed in accordance with the ABCB Housing Provisions (Part 13.5.2) of the National Construction Code .

Glazed window/door no.	Maximum height (mm)	Maximum width (mm)	Frame and glass specification	Shading device (Dimension within 10%)	Overshadowing		
North facing	North facing						
Door 06	2100.00	2110.00	aluminium, single glazed (U- value: <=5.0, SHGC: 0.74 - 0.90)	verandah 1470 mm, 2385 mm above base of window or glazed door	not overshadowed		
W09	600.00	1210.00	aluminium, single glazed (U- value: <=5.0, SHGC: 0.74 - 0.90)	eave 580 mm, 343 mm above head of window or glazed door	not overshadowed		
W05	600.00	1810.00	aluminium, single glazed (U- value: <=5.0, SHGC: 0.74 - 0.90)	eave 580 mm, 343 mm above head of window or glazed door	not overshadowed		

Glazed window/door no.	Maximum height (mm)	Maximum width (mm)	Frame and glass specification	Shading device (Dimension within 10%)	Overshadowing
W10	600.00	1810.00	aluminium, single glazed (U- value: <=5.0, SHGC: 0.74 - 0.90)	eave 580 mm, 343 mm above head of window or glazed door	not overshadowed
East facing					
W12	1000.00	1010.00	aluminium, single glazed (U-value: <=5.0, SHGC: 0.74 - 0.90)	eave 890 mm, 343 mm above head of window or glazed door	not overshadowed
W12	1000.00	1010.00	aluminium, single glazed (U- value: <=5.0, SHGC: 0.74 - 0.90)	eave 890 mm, 343 mm above head of window or glazed door	not overshadowed
South facing					
W05	600.00	1810.00	aluminium, single glazed (U- value: <=5.0, SHGC: 0.74 - 0.90)	eave 580 mm, 343 mm above head of window or glazed door	1-2 m high, <1.5 m away
W05	600.00	1810.00	aluminium, single glazed (U- value: <=5.0, SHGC: 0.74 - 0.90)	eave 580 mm, 343 mm above head of window or glazed door	1-2 m high, <1.5 m away
W11	600.00	910.00	aluminium, single glazed (U- value: <=5.0, SHGC: 0.74 - 0.90)	eave 580 mm, 343 mm above head of window or glazed door	1-2 m high, <1.5 m away
W10	600.00	1810.00	aluminium, single glazed (U-value: <=5.0, SHGC: 0.74 - 0.90)	eave 580 mm, 343 mm above head of window or glazed door	1-2 m high, <1.5 m away
West facing					
W08	1200.00	1810.00	aluminium, single glazed (U- value: <=5.0, SHGC: 0.74 - 0.90)	verandah 1510 mm, 1280 mm above base of window or glazed door	not overshadowed

The applicant must install the following hot water system in the development, or a system with a higher energy rating: gas instantaneous with a performance of 6 stars.

The applicant must install the following cooling system, or a system with a higher energy rating, in at least 1 living area: 1-phase airconditioning - ducted; Energy rating: 3.5 star (average zone)

The applicant must install the following cooling system, or a system with a higher energy rating, in at least 1 bedroom: 1-phase airconditioning - ducted; Energy rating: 3.5 star (average zone)

# Heating system

The applicant must install the following heating system, or a system with a higher energy rating, in at least 1 living area: 1-phase airconditioning - ducted; Energy rating: 3.5 star (average zone)

The applicant must install the following heating system, or a system with a higher energy rating, in at least 1 bedroom: 1-phase airconditioning - ducted; Energy rating: 3.5 star (average zone)

# Ventilation

The applicant must install the following exhaust systems in the development:

At least 1 Bathroom; individual fan, ducted to facade or roof; Operation control; manual switch on/off

Kitchen: individual fan, open to façade; Operation control: manual switch on/off

Laundry: natural ventilation only, or no laundry; Operation control: n/a

## Artificial lighting

The applicant must ensure that a minimum of 80% of light fixtures are fitted with fluorescent, compact fluorescent, or light-emitting-

## **Natural lighting**

The applicant must install a window and/or skylight in the kitchen of the dwelling for natural lighting.

# **Energy Commitments**

The applicant must install a window and/or skylight in 1 bathroom(s)/toilet(s) in the development for natural lighting

## Other

The applicant must install a gas cooktop & electric oven in the kitchen of the dwelling.

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ACCREDITED BUILDING DESIGNER

Rajat and Pooja Karwal

Dual Occupancy & Sec. Dwellings at:

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# **ENERGY EFFICIENCY NOTES** & GENERAL NOTES Drawn By: Drawing No. Scale: NTS dbb

Date: Issue: 08/07/25 DA-A en.eff3

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# Single Dwelling 4

Certificate number: 1810186S

### Water Commitments

The applicant must install showerheads with a minimum rating of 4 star (> 4.5 but <= 6 L/min plus spray force and/or coverage tests) in all showers in the development.

The applicant must install a toilet flushing system with a minimum rating of 6 star in each toilet in the development.

The applicant must install taps with a minimum rating of 6 star in the kitchen in the development.

The applicant must install basin taps with a minimum rating of 5 star in each bathroom in the development.

## Alternative water

Rainwater tank

The applicant must install a rainwater tank of at least 1500 litres on the site. This rainwater tank must meet, and be installed in accordance with, the requirements of all applicable regulatory authorities.

The applicant must configure the rainwater tank to collect rain runoff from at least 165.6 square metres of the roof area of the

The applicant must connect the rainwater tank to:

at least one outdoor tap in the development (Note: NSW Health does not recommend that rainwater be used for human consumption in areas with potable water supply.)

Construction	Area - m²	Additional insulation required	Options to address thermal bridging	Other specifications
floor - concrete slab on ground, conventional slab.	60.2	nil;not specified	nil	
external wall: brick veneer; frame: timber - H2 treated softwood.	all external walls	2.94 (or 3.50 including construction); fibreglass batts or roll	nil	wall colour: Medium (solar absorptance 0.48-0.7)
internal wall: plasterboard; frame: timber - H2 treated softwood.	68.5	fibreglass batts or roll	nil	

Construction	Area - m²	Additional insulation required	Options to address thermal bridging	Other specifications
ceiling and roof - flat ceiling / pitched roof, framed - metal roof, timber - H2 treated softwood.	94.8	ceiling: 4 (up), roof: foil/ sarking ;ceiling: fibreglass batts or roll; roof: foil/sarking.	nil	roof space ventilation: unventilated; roof colour: light (solar absorptance < 0.38); ceiling area fully insulated

1.	
Note	Insulation specified in this Certificate must be installed in accordance with the ABCB Housing Provisions (Part 13.2.2) of the National Construction Code.
Note	• If the additional ceiling insulation listed in the table above is greater than R3.0, refer to the ABCB Housing Provisions (Part 13.2.3 (6)) of the National Construction Code.
Note	In some climate zones, insulation should be installed with due consideration of condensation and associated interaction with adjoining building materials.
Note	Thermal breaks must be installed in metal framed walls and applicable roofs in accordance with the ABCB Housing Provisions of the National Construction Code.

# Thermal Performance and Materials commitments

Ceiling fans

The applicant must install at least one ceiling fan in at least one daytime habitable space, such as living room.

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The minimum number and diameter of celling fans in a daytime habitable space must be installed in accordance with the ABCB Housing Provisions (Part 13.5.2) of the National Construction Code .

Glazed window/door no.	Maximum height (mm)	Maximum width (mm)	Frame and glass specification	Shading device (Dimension within 10%)	Overshadowing	
North facing						
W05	600.00	1810.00	aluminium, single glazed (U- value: <=5.0, SHGC: 0.74 - 0.90)	eave 580 mm, 343 mm above head of window or glazed door	1-2 m high, <1.5 m away	
W05	600.00	1810.00	aluminium, single glazed (U- value: <=5.0, SHGC: 0.74 - 0.90)	eave 580 mm, 343 mm above head of window or glazed door	1-2 m high, <1.5 m away	
W11	600.00	910.00	aluminium, single glazed (U- value: <=5.0, SHGC: 0.74 - 0.90)	eave 580 mm, 343 mm above head of window or glazed door	1-2 m high, <1.5 m away	

Glazed window/door no.	Maximum height (mm)	Maximum width (mm)	Frame and glass	Shading device (Dimension within 10%)	Overshadowing		
W10	600.00	1810.00	aluminium, single glazed (U- value: <=5.0, SHGC: 0.74 - 0.90)	eave 580 mm, 343 mm above head of window or glazed door	1-2 m high, <1.5 m away		
East facing		•	•				
W12	1000.00	1010.00	aluminium, single glazed (U-value: <=5.0, SHGC: 0.74 - 0.90)	eave 890 mm, 343 mm above head of window or glazed door	not overshadowed		
W12	1000.00	1010.00	aluminium, single glazed (U- value: <=5.0, SHGC: 0.74 - 0.90)	eave 890 mm, 343 mm above head of window or glazed door	not overshadowed		
South facing		•	•				
Door 06	2100.00	2110.00	aluminium, single glazed (U- value: <=5.0, SHGC: 0.74 - 0.90)	verandah 1470 mm, 2400 mm above base of window or glazed door	not overshadowed		
W14	600.00	1210.00	aluminium, single glazed (U-value: <=5.0, SHGC: 0.74 - 0.90)	eave 580 mm, 343 mm above head of window or glazed door	1-2 m high, <1.5 m away		
W05	600.00	1810.00	aluminium, single glazed (U-value: <=5.0, SHGC: 0.74 - 0.90)	eave 580 mm, 343 mm above head of window or glazed door	1-2 m high, <1.5 m away		
W10	600.00	1810.00	aluminium, single glazed (U- value: <=5.0, SHGC: 0.74 - 0.90)	eave 580 mm, 343 mm above head of window or glazed door	1-2 m high, <1.5 m away		
West facing							
W08	1200.00	1810.00	aluminium, single glazed (U-value: <=5.0, SHGC: 0.74 - 0.90)	verandah 1510 mm, 1280 mm above base of window or glazed door	not overshadowed		

## Hot water

The applicant must install the following hot water system in the development, or a system with a higher energy rating: gas instantaneous with a performance of 6 stars.

The applicant must install the following cooling system, or a system with a higher energy rating, in at least 1 living area: 1-phase airconditioning - ducted; Energy rating: 3.5 star (average zone)

The applicant must install the following cooling system, or a system with a higher energy rating, in at least 1 bedroom: 1-phase airconditioning - ducted; Energy rating: 3.5 star (average zone)

### Heating system

The applicant must install the following heating system, or a system with a higher energy rating, in at least 1 living area: 1-phase airconditioning - ducted; Energy rating: 3.5 star (average zone)

The applicant must install the following heating system, or a system with a higher energy rating, in at least 1 bedroom: 1-phase airconditioning - ducted; Energy rating: 3.5 star (average zone)

The applicant must install the following exhaust systems in the development:

At least 1 Bathroom: individual fan, ducted to façade or roof; Operation control: manual switch on/off

Kitchen: individual fan, open to facade: Operation control: manual switch on/off

Laundry: natural ventilation only, or no laundry; Operation control: n/a

## Artificial lighting

The applicant must ensure that a minimum of 80% of light fixtures are fitted with fluorescent, compact fluorescent, or light-emittingdiode (LED) lamps

The applicant must install a window and/or skylight in the kitchen of the dwelling for natural lighting.

# **Energy Commitments**

The applicant must install a window and/or skylight in 1 bathroom(s)/toilet(s) in the development for natural lighting.

The applicant must install a gas cooktop & electric oven in the kitchen of the dwelling

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ACCREDITED BUILDING DESIGNER

Rajat and Pooja Karwal

Dual Occupancy & Sec. Dwellings at: L11, 63 Queen Street, Revesby dp2343

01/09/25 DA SUBMISSION No. Date

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**ENERGY EFFICIENCY NOTES** & GENERAL NOTES Scale: Drawn By: Drawing No. NTS dbb en.eff4 Date: Issue: 08/07/25 DA-A



WEST ELEVATION
FRONT ELEVATION
(TO QUEEN STREET) D2 🔥

Α

No. 61

No. 65



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Rajat and Pooja Karwal Project Title : Dual Occupancy & Sec. Dwellings at: L11, 63 Queen Street, Revesby dp2343

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STREET SCAPE Drawing No. Drawn By: Scale: NTS dbb Ssc Issue: Date: 08/07/25 DA-A